

DA SET - REV J 3 COLLINGWOOD AVENUE, EARLWOOD

FOR CLIENT : DINESH SRINIVASAN 23RD DECEMBER, 2024









- 1. GARDEN/PLANTING STYLE
- 2. FEATURE TREE REFERENCE
- 3. MILD STEEL GARDEN EDGING

SCALE: N/A

DRAWN: MT

CHECKED: AC

SHEET #: 01

4. COWRA WHITE PEBBLE



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 4/11/24

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 DA SET DRAFT
 12/12/24

 J
 DA SET
 23/12/24

PROJECT: 3 COLLINGWOOD AVENUE EARLWOOD

CLIENT: DINSESH SRINIVASAN

PROJECT #: SRI COUNCIL: CANTERBURY

DRAWING TITLE: INSPIRATION PALETTE

Landscape Design Institute

Professional Member

GENERAL NOTES.

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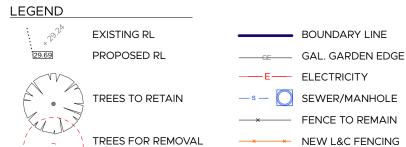
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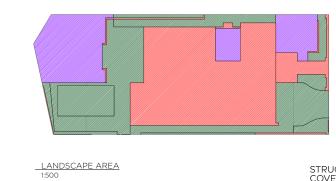
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POOL FENCE

REQUIREMENT	REQUIRED	PROPOSED	COMPLY
SITE AREA: 598.4m2			
MAX COVERAGE OF ALL STRUCTURES:	MAX 50% (299.2m2)	255.373m2	YES
DEEP SOIL PERMEABLE AREA:	MINIMUM 20% (119.7m2)	120.048m2	YES
TOTAL LANDSCAPE AREA:		342.95m2	



CONCRETE

POOL

PROPOSED TURF

EXISTING TURF

MULCH

GROUND

STRUCTURE COVERAGE

DEEP SOIL AREA

LANDSCAPE AREA

COVER

PAVERS

PEBBLES

STONE CLADDING

MASONRY RET WALL


DECK

SUBSOIL

DECO GRANITE

TIMBER RET WALL

SHADED AREA INDICATES CERTIFICATION BY OTHERS

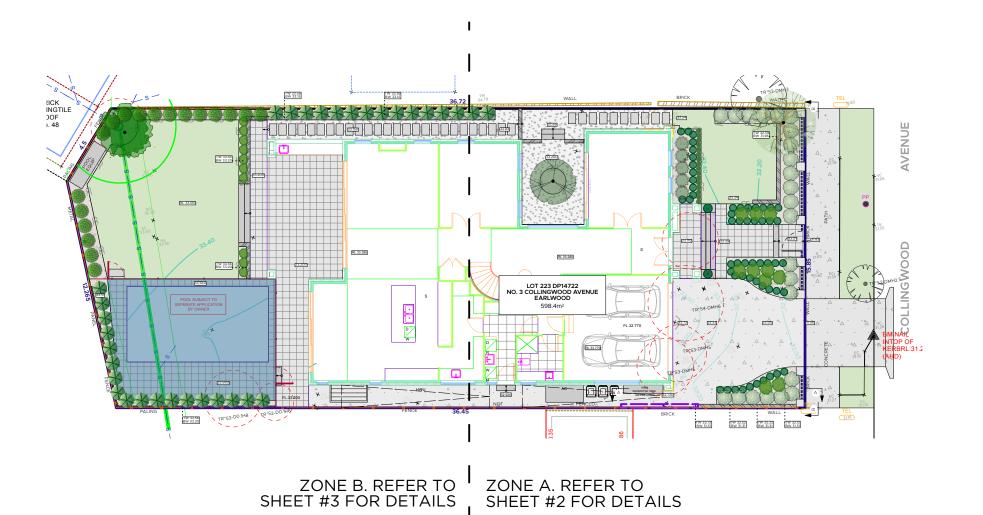



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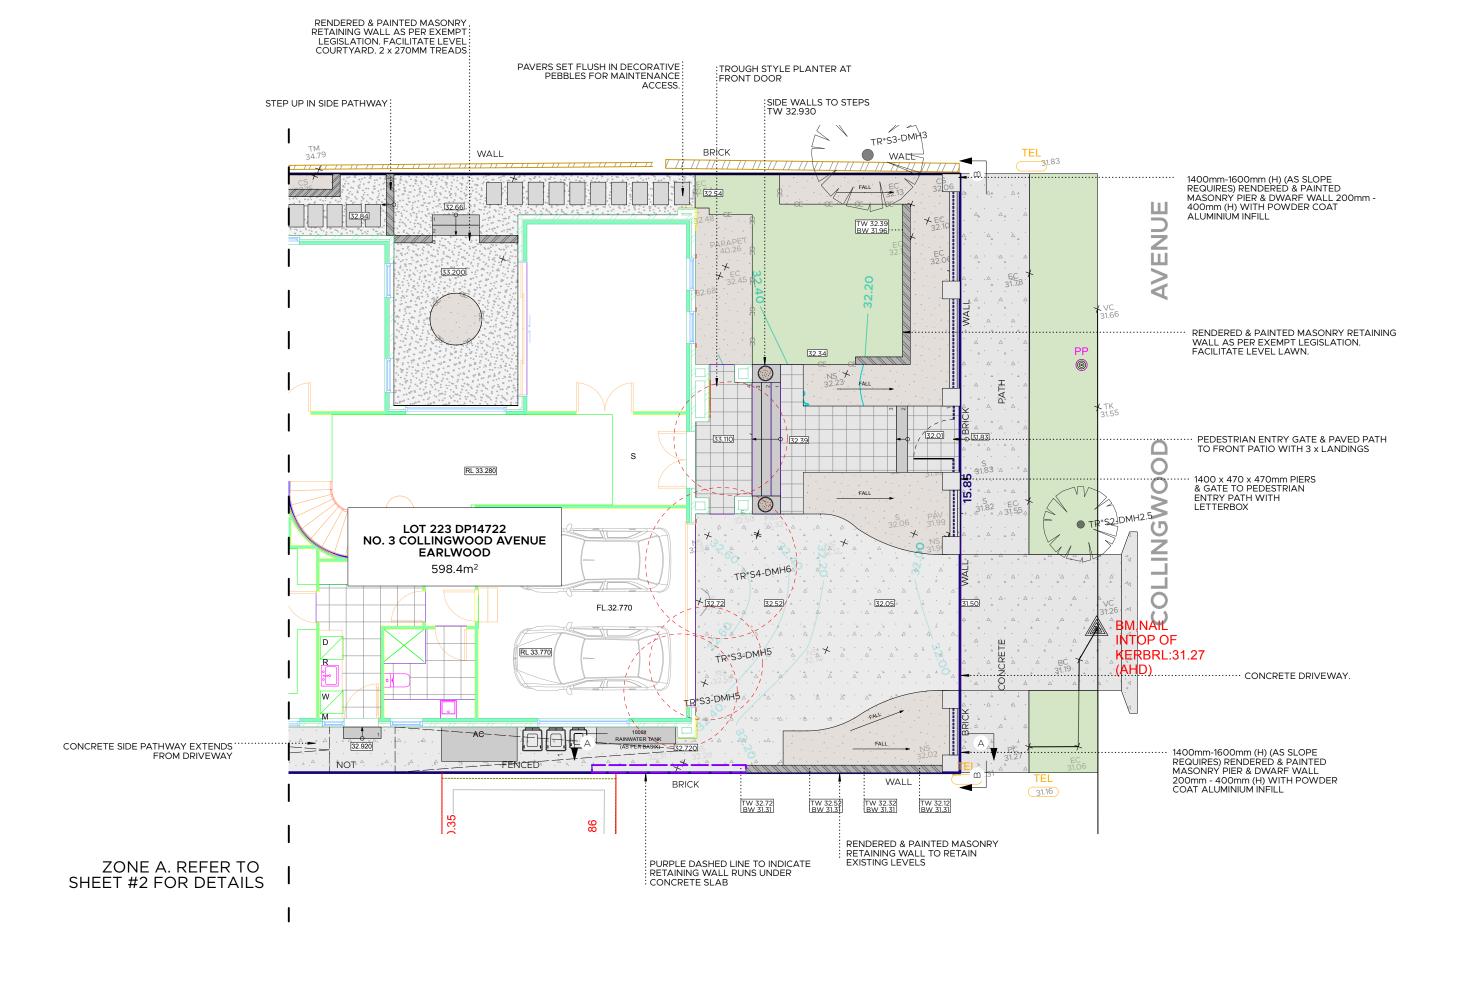
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DA SET	23/12/24

-	PROJECT: 3 COLLINGWOOD AVENUE EARLWOOD	
CLIENT: DINSESH SRINIVASAN		
	PROJECT #: SRI COUNCIL: CANTERBURY	
1	DRAWING TITLE: LANDSCAPE SITE PLAN	



SCALE: 1:200 @ A3	
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+	PROJECT: 3 COLLINGWOOD AVENUE EARLWOOD	
1	CLIENT: DINSESH SRINIVA	SAN
•	PROJECT #: SRI	COUNCIL: CANTERBURY
1 4	DRAWING TITLE: ZONE A - LA	ANDSCAPE PLAN



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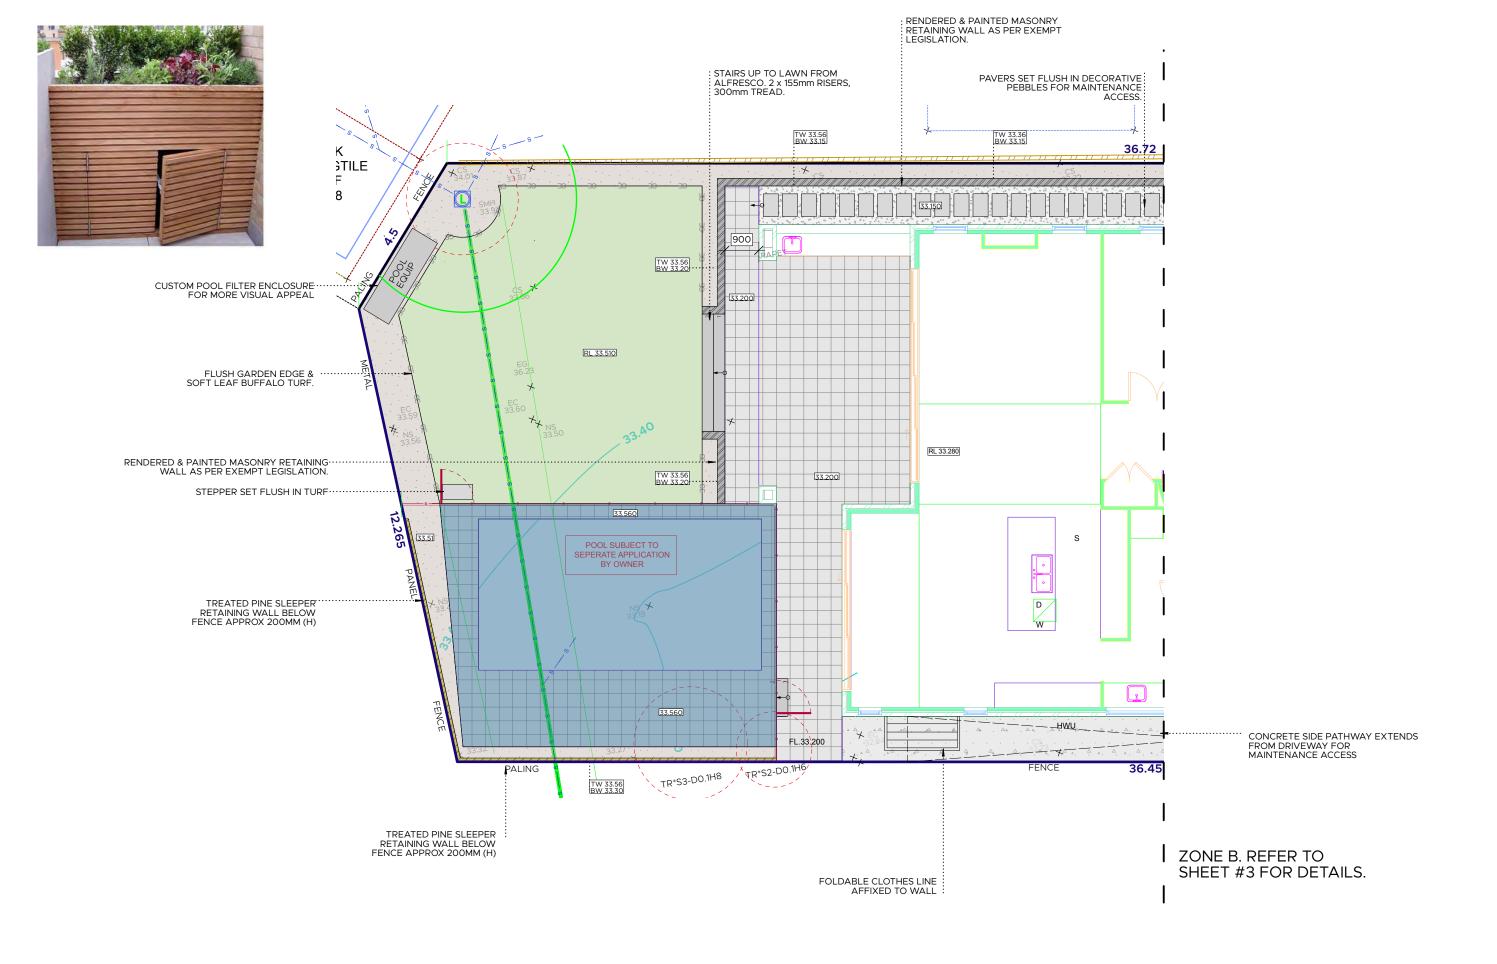
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	DRAWING TITLE: ZONE B - LANDSCAPE PLAN		



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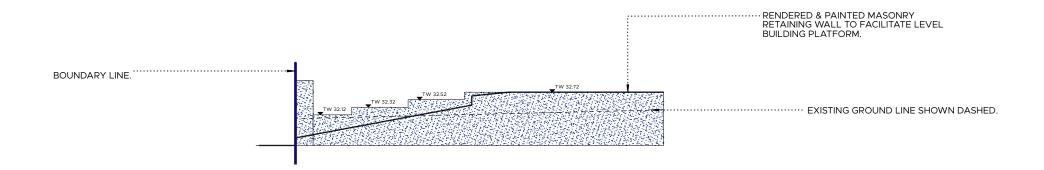
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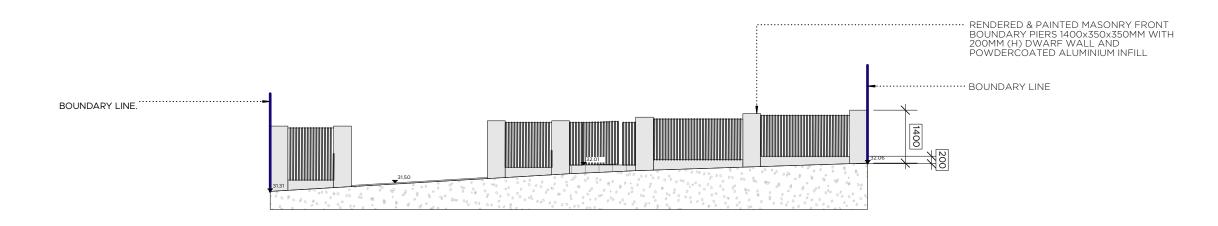
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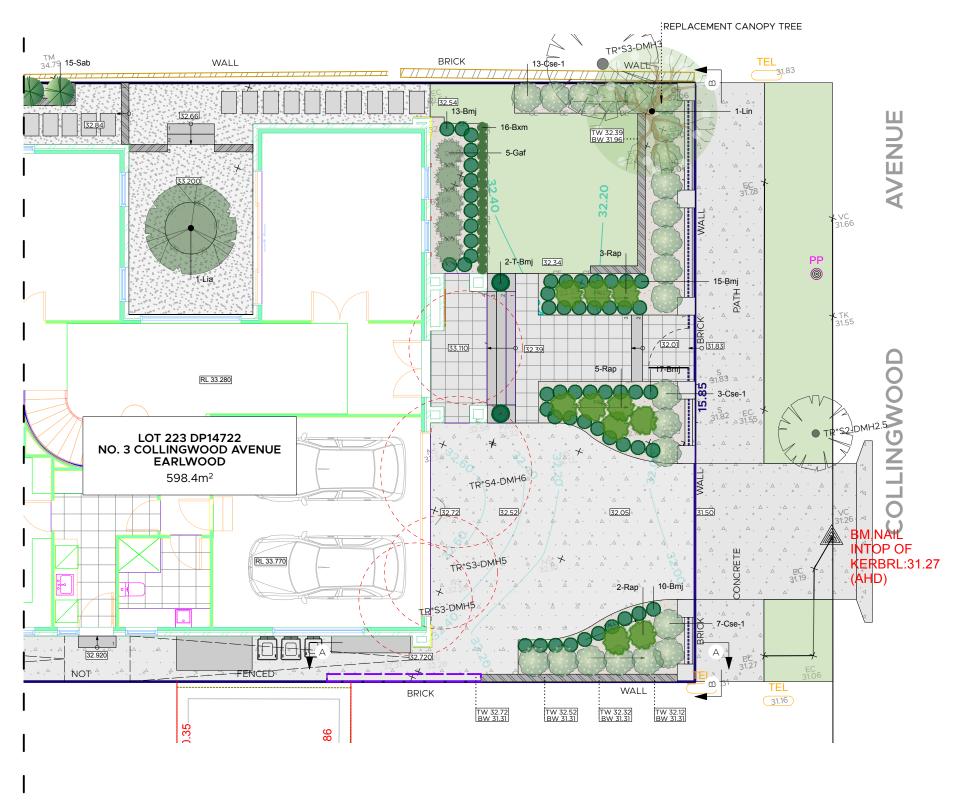
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1	PROJECT: 3 COLLINGWOOD AVENUE EARLWOOD
4	CLIENT: DINSESH SRINIVASAN
4	PROJECT #: SRI COUNCIL: CANTERBURY
4 4	DRAWING TITLE: SECTIONAL ELEVATIONS

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CHECKED: AC	Institute
	Professional Member

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ZONE A. REFER TO SHEET #2 FOR DETAILS

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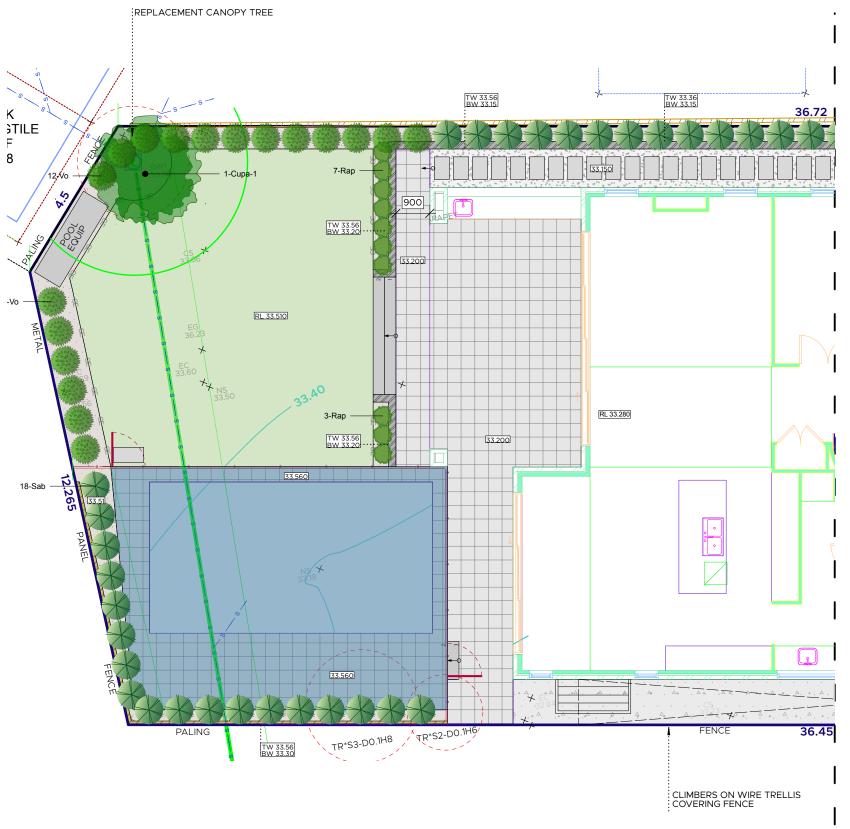
4	PROJECT: 3 COLLINGWOOD AVENUE EARLWOOD					
4	CLIENT: DINSESH SRINIVASAN					
4 1 4	*	COUNCIL: CANTERBURY				
4	DRAWING TITLE: ZONE A - PLANTING PLAN					



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ZONE B. REFER TO SHEET #3 FOR DETAILS.

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PROJECT: 3 COLLINGWOOD AVENUE EARLWOOD						
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	DRAWING TITLE: ZONE B - PLANTING PLAN					



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IMAGES	ID	QTY	COMMON NAME	BOTANICAL NAME	POT SIZE	MATURE HEIGHT	MATURE SPREAD	MAINTENANCE (FIRST 2 YEARS)
TREES								
	Cupa-	1	Tuckeroo	Cupaniopsis anacardioides	500mm	10m	5-8m	Use hesian and stakes for support during establisment period. Remove lower wayawrd branches from the base, if necessary, to promote a uniform shape.
8	Lia	1	Acoma Crepe Myrtle	Lagerstroemia indica x L. fauriei 'Acoma' Indian Summer	500mm	3m	3m	Use hesian and stakes for support during etablishment period.
	Lin	1	Indian Summer Crepe Myrtle	Lagerstroemia indica 'Natchez'	45L	4m	3.5m	Use hesian and stakes for support during establisment period. Remove lower wayawrd branches from the base to promote a uniform shape.
SHRUBS	•	•						
	Bmj	55	Japanese Box	Buxus microphylla japonica	200mm	1.5 - 3m	1.2 - 2.0m	Pruning & shaping may need to be done several times during growing season (spring/summer). Feed in Autumn/Spring with a complete fertiliser.
	Bxm	16	Japanese Box	Buxus microphylla var. microphylla	140mm	0.2-0.6m	0.4m	Pruning & shaping may need to be done several times during growing season (spring/summer). Feed in Autumn/Spring with a complete fertiliser.
	Cse-1	23	Camellia Setsugekka	Camellia sasanqua 'Setsugekka'	200mm	2.5m	1.5m	Water regularly. Add azalea/Camelia specific fertilizer bi-annually to encourage flowering and vigourous growth
	Gaf	5	Gardenia Florida	Gardenia augusta 'Florida'	200mm	0.8-1.0m	0.8-1.0m	Keep well watered. Tip prune after flowering to maintain shape and compact growth. Feed with control release fertilizer in spring
	Rap	20	Indian Hawthorn	Raphiolepis 'Oriental Pearl'	200mm	0.8-1.0m	0.8-1.0m	Water well to establish. Prune to shape in spring, Apply a well balanced fertiliser in mid spring
*	Sab	33	Lilly pilly 'Backyard Bliss'	Syzygium australe 'Backyard Bliss'	300mm	2.0-4.0m	1.0-1.5m	Prune to shape during early spring. Use a native fertiliser annually
	T-Bmj	2	Japanese Box	TEARS - Buxus microphylla japonica	300mm	1.5 - 3m	1.2 - 2.0m	Pruning & shaping may need to be done several times during growing season (spring/summer). Feed in Autumn/Spring with a complete fertiliser.
	Vo	18	Viburnum	Viburnum odoratissmum	300mm	3 - 5m	3.5 - 6m	Water well till established. Tip prune while young to encourage bushy growth.
LOW PLANTS & GROUND COVERS								
Total		175						

























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PROJECT: 3 COLLINGWOOD AVENUE EARLWOOD

CLIENT: DINSESH SRINIVASAN

PROJECT #: SRI COUNCIL: CANTERBURY

DRAWING TITLE: PLANTING SCHEDULE

DRAWN: MT

CHECKED: AC

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PLANT & MAINTENANCE SPECIFICATIONS

1. PREPARE THE SITE FOR OPTIMUM PLANT GROWTH


Ensure trees and shrubs are removed that need to be removed. Remove all building rubble from garden beds and lawn areas. Remove weeds: Spray 'Roundup' or similar product. Follow the manufacturers instructions. Ensure weeds are dead before pulling out. Ensure there is proper stormwater run-off and drainage on site. Compacted soil should be loosened and, where applicable (in clay soil) gypsum added. Fill garden beds with a minimum 300mm organic garden mix. Sprinkle granular wetting agent and water in well according to packet instructions.

2. PLANTING THE PLANTS AND TREES

Stand plant pots in their position according to the planting plan. Dig a hole 1.5 times the width, and the same depth as the plant pot. Carefully remove the plants from the pots so as not to disturb the roots. Plant the plant so that the top of the root ball is level with the soil. Trees are to be staked with 3x (50x50x1800)mm hardwood stakes. Tie the trees and stakes with hessian. Avoid the rootball when inserting the stake. The stakes need to stay for at least 18 months for high wind areas.

3. LAWN

Ensure the turf is disease and weed free. Apply 150mm layer of good quality turf underlay. Level the topsoil into a smooth surface. Ensure the turf is finished at appropriate (flush) levels with adjoining paving or edging. Apply topdressing if/where required. Water often over the first 4 weeks. Gradually cut back the water to weekly in the first summer. Check the levels 2-4 times annually to topdress any depressions due to compaction over time. Hand weeding on a regular basis is important when the lawn is establishing.

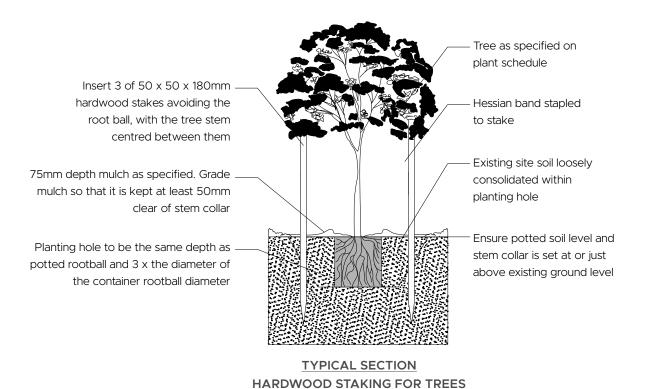

4. IRRIGATION AND WATER

It is advised to run irrigation tubing over the soil and under the mulch. This is connected to a tap with a manual or automatic timer to ensure plants get sufficient water during establishment period to grow healthy and pest and disease free. Water plants well 3-4 times per week in the first month and 2 times per week in the second month (depending on weather conditions). Occasional hose watering is advised to allow even distribution of water to the roots. Apply a wetting agent to help soil maintain moisture and not become hydrophobic.


Fertilise with a general purpose slow release fertiliser such as 'Osmocote' or 'Nutricote'. Fertilize natives with 'Osmocote for Natives'. Apply as per manufacturers specifications for the plants size and type. Fertilizer needs to be reapplied regularly during the growing period, follow packet directions. Always under fertilise rather than over fertilise. Occasional dressing of organic compost is beneficial to all soils. Plants can benefit from seaweed solution during establishment stage.


6. MULCH

Cover the entire soil surface with a minimum of 75mm eucalyptus mulch or cypress mulch. The mulch surrounding trees needs to be less near the base of the trunk, to form a shallow watering dish. Care should be taken not to mix the mulch with the soil. Mulch suppresses weeds as well as preventing soil dehydration. Top up mulch annually or as required so that the correct thickness is maintained. Use an organic mulch such as Eucalyptus mulch, Cypress mulch/woodchip. Sugarcane or Lucern mulches are best suited for vegetable gardens.

7. TRIMMING

Prune hedges to desired height from a very young age by using a level string line. Tip prune all young plants to ensure compact and lush growth. Follow instructions in the above table for specific plants.

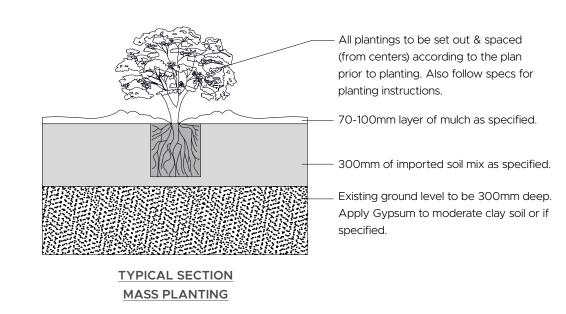

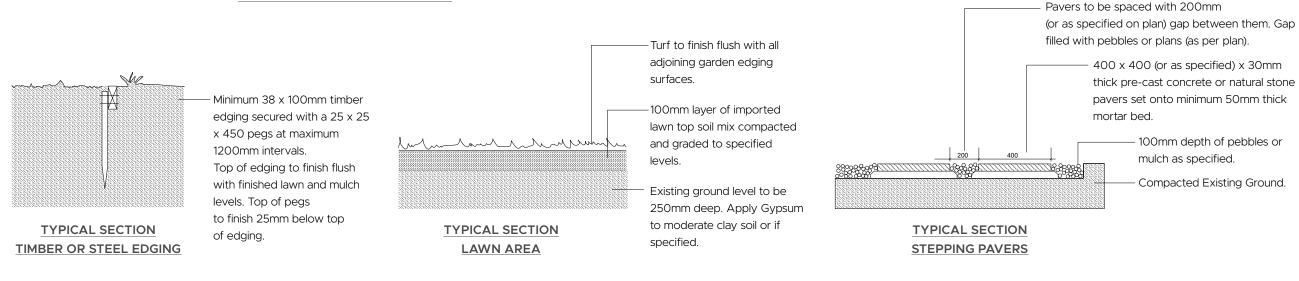



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PROJECT #: SRI C	OUNCIL: CANTERBURY				
DRAWING TITLE: PLANT & MAI	NTENANCE SPECS				

SCALE: 1:100 @ A3 DRAWN: MT Landscape Design Institute CHECKED: AC Professional Member SHEET #: 8

400 x 400 (or as specified) x 30mm

thick pre-cast concrete or natural stone

100mm depth of pebbles or

Compacted Existing Ground.

pavers set onto minimum 50mm thick

mulch as specified.

mortar bed.

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